


# US Department of Veterans Affairs

Program Contracting Activity Central (PCAC)  
6150 Oak Tree Blvd, Suite 300  
Independence, Ohio 44131

## E85 FUELING STATION

VA Medical Center  
3600 30th Street  
Des Moines, Iowa 50310

IDIQ #VA701-12-D-0038  
Task Order #VA701-13-J-0154

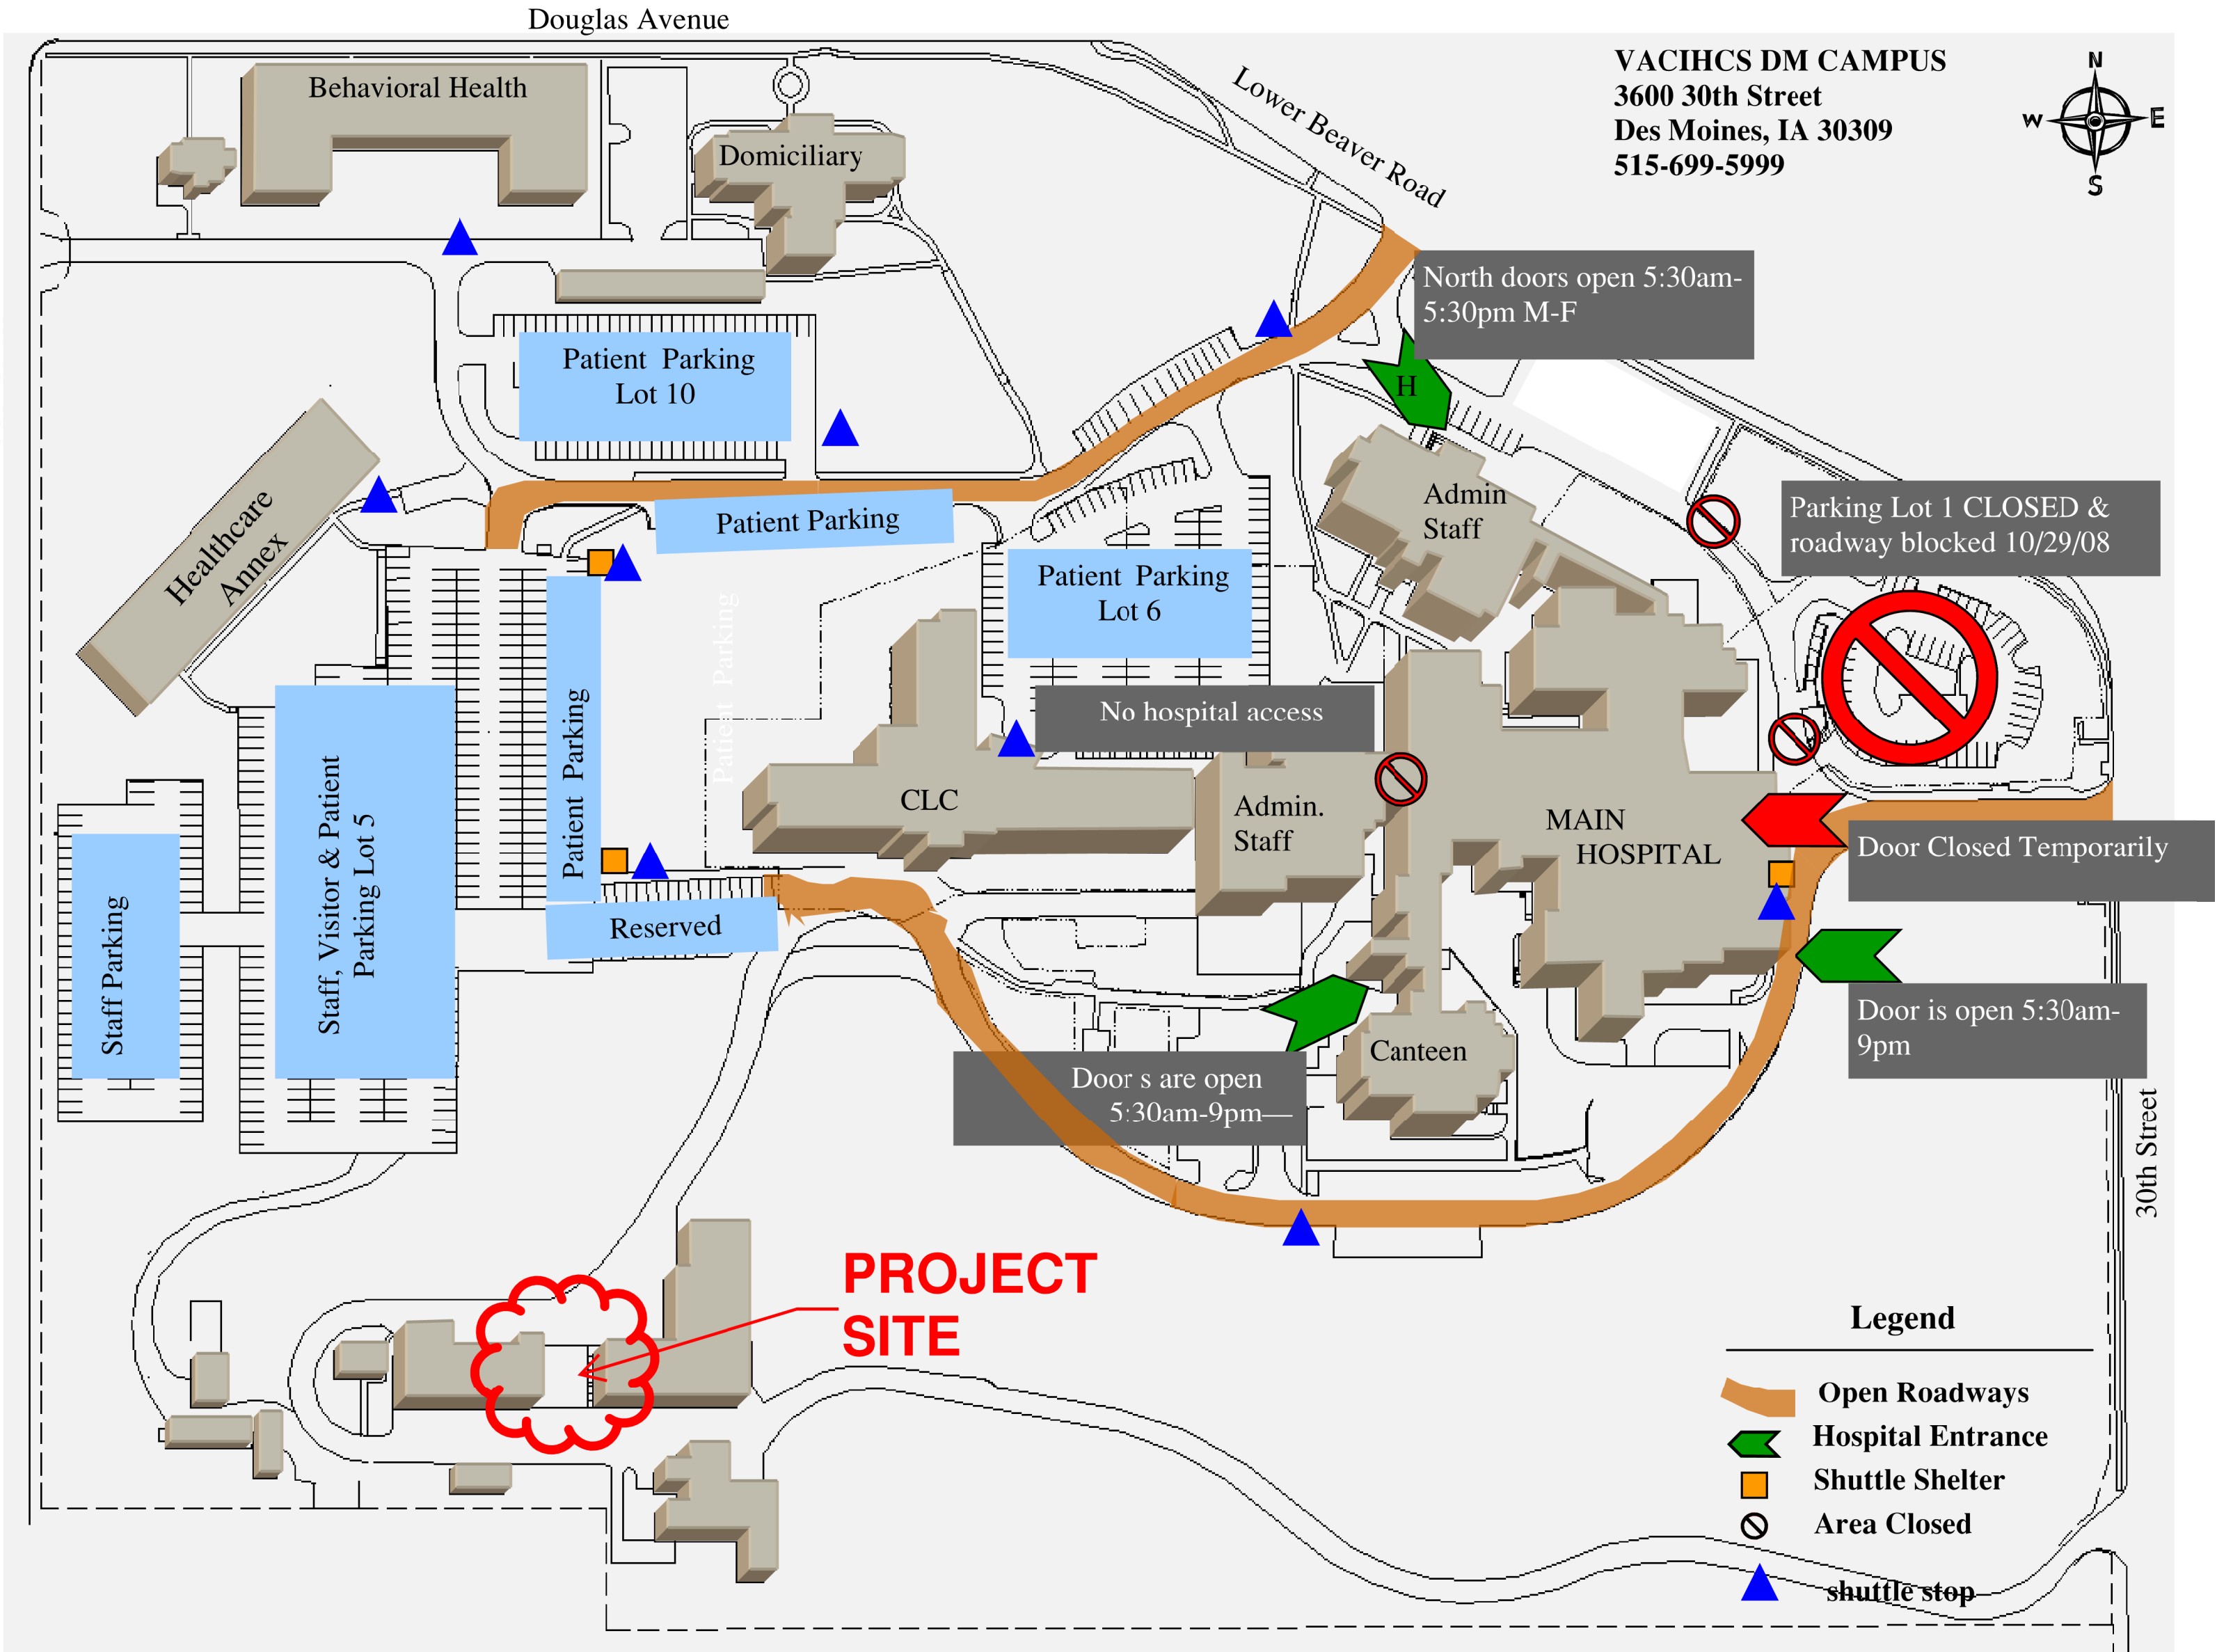

### LIST OF DRAWINGS

- G-001 COVER SHEET
- CU-101 EXISTING CONDITIONS
- CU-102 SITE PLAN
- MS-101 MECHANICAL PLAN, DETAILS, & SCHEDULE
- ES-101 ELECTRICAL SITE PLAN



### CONSTRUCTION BID DOCUMENTS


<b>PROJECT TEAM</b>		<b>ARCHITECTS/ENGINEERS</b>		<b>HDR</b>		<b>COVER SHEET</b>		<b>E85 FUEL STATION</b>		<b>Office of Construction and Facilities Management</b>	
ARCHITECTURAL: MECHANICAL/ELECTRICAL/PLUMBING: STRUCTURAL: CIVIL/SURVEYOR: FIRE PROTECTION: COMMISSIONING AGENCY: ENVIRONMENTAL SERVICES:		ANDERSON ENGINEERING ENGINEERING • ARCHITECTURE • LAND SURVEYING ENVIRONMENTAL SERVICES • LANDSCAPE ARCHITECTURE		444 CEDAR STREET, SUITE 1900, ST. PAUL, MN 55101		Drawing Title: COVER SHEET Approved: Project Director		Project Title: E85 FUEL STATION Location: 3600 30TH STREET DES MOINES, IA 50310 Date: 08/01/2014		Project Number: 222514 Building Number: Drawing number: G-001	
NO REVISIONS DATE		EMR				Checked by: Checker Date: 08/01/2014		Drawn: Author			





- |                 |                      |
|-----------------|----------------------|
|                 | SIGN                 |
|                 | POST INDICATOR VALVE |
|                 | SOIL BORING          |
|                 | ELECTRIC BOX         |
|                 | AUTO SPRINKLER       |
|                 | AIR CONDITIONER      |
|                 | CATCH BASIN          |
|                 | HYDRANT              |
|                 | STORM MANHOLE        |
|                 | WATER VALVE          |
| _____ OHW _____ | OVERHEAD WIRES       |
| _____ >> _____  | STORM SEWER          |
| _____ T _____   | TELEPHONE            |
| _____ UE _____  | UNDERGROUND ELECTRIC |
| _____ I _____   | WATER MAIN           |

- GENERAL NOTES:
1. FINAL GRADES SHALL MATCH EXISTING GRADING
  2. EROSION CONTROL BLANKETS SHALL BE INSTALLED OVER ALL DISTURBED SOIL
  3. ANY DISTURBED PAVEMENT SHALL BE REPLACED IN-KIND
  4. CONTRACTOR IS RESPONSIBLE FOR VERIFYING EXISTING UTILITY LOCATIONS.
  5. NEW FUEL PUMP SHALL BE INSTALLED 20FT MIN AWAY FROM ALL BUILDINGS
  6. PROTECT ALL EXISTING UTILITIES AND STRUCTURES (TYP)
  7. SEE EXISTING CONDITIONS PLAN FOR ADDITIONAL UTILITY INFORMATION
  8. CONTRACTOR TO VERIFY STOCK PILE LOCATION WITH RESIDENT ENGINEER

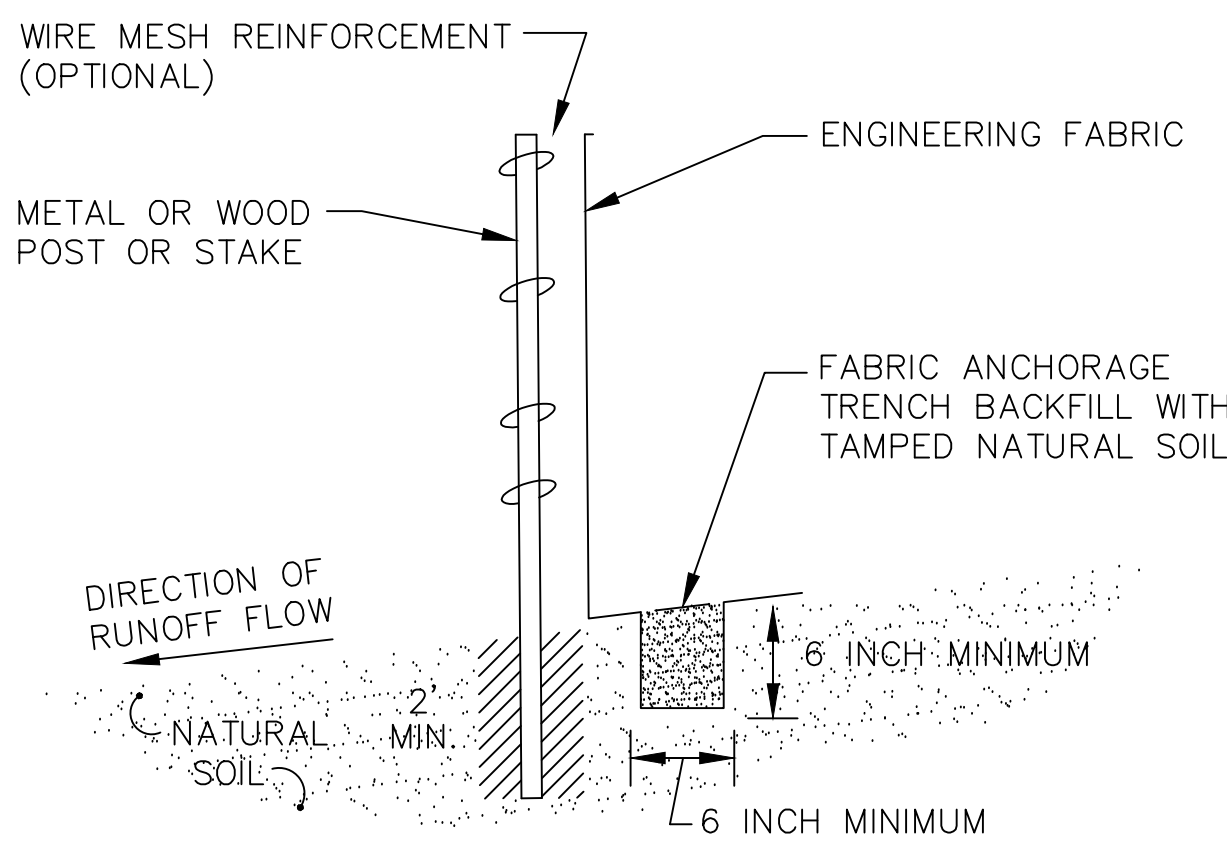

NOTE: DEPENDING UPON CONFIGURATION, ATTACH FABRIC TO WIRE MESH WITH HOG RINGS, STEEL POSTS WITH TIE WIRES, OR WOOD POSTS WITH STAPLES.

### TYPICAL INSTALLATION FOR SILT FENCE

# CONSTRUCTION BID DOCUMENTS

NO	REVISIONS	DATE

PROJECT TEAM						
<u>ARCHITECTURAL</u>	<u>MECHANICAL/ELECTRICAL ENGINEERING</u>	<u>STRUCTURAL</u>	<u>CIVIL / SURVEYOR</u>	<u>PILE PROTECTION</u>	<u>COMMISSIONING AGENCY</u>	<u>ENVIRONMENTAL SERVICES</u>

**ARCHITECTS/ENGINEERS**




ENGINEERING • ARCHITECTURE • LAND SURVEYING  
ENVIRONMENTAL SERVICES • LANDSCAPE ARCHITECTURE






EMR  
Engineering, Management, Research  
INFRASTRUCTURE AND ENVIRONMENT

444 CEDAR STREET, SUITE 1900,  
ST. PAUL, MN 55101

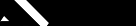Drawing Title  SITE PLAN	Project Title  E85 FUEL STATION			Project Number 222514	Office of Construction and Facilities Management
				Building Number	
Approved : Project Director	Location 3600 30TH STREET DES MOINES, IA 50310			Drawing number  CU-102	
	Date 08/01/2014	Checked by Checker	Drawn Author		





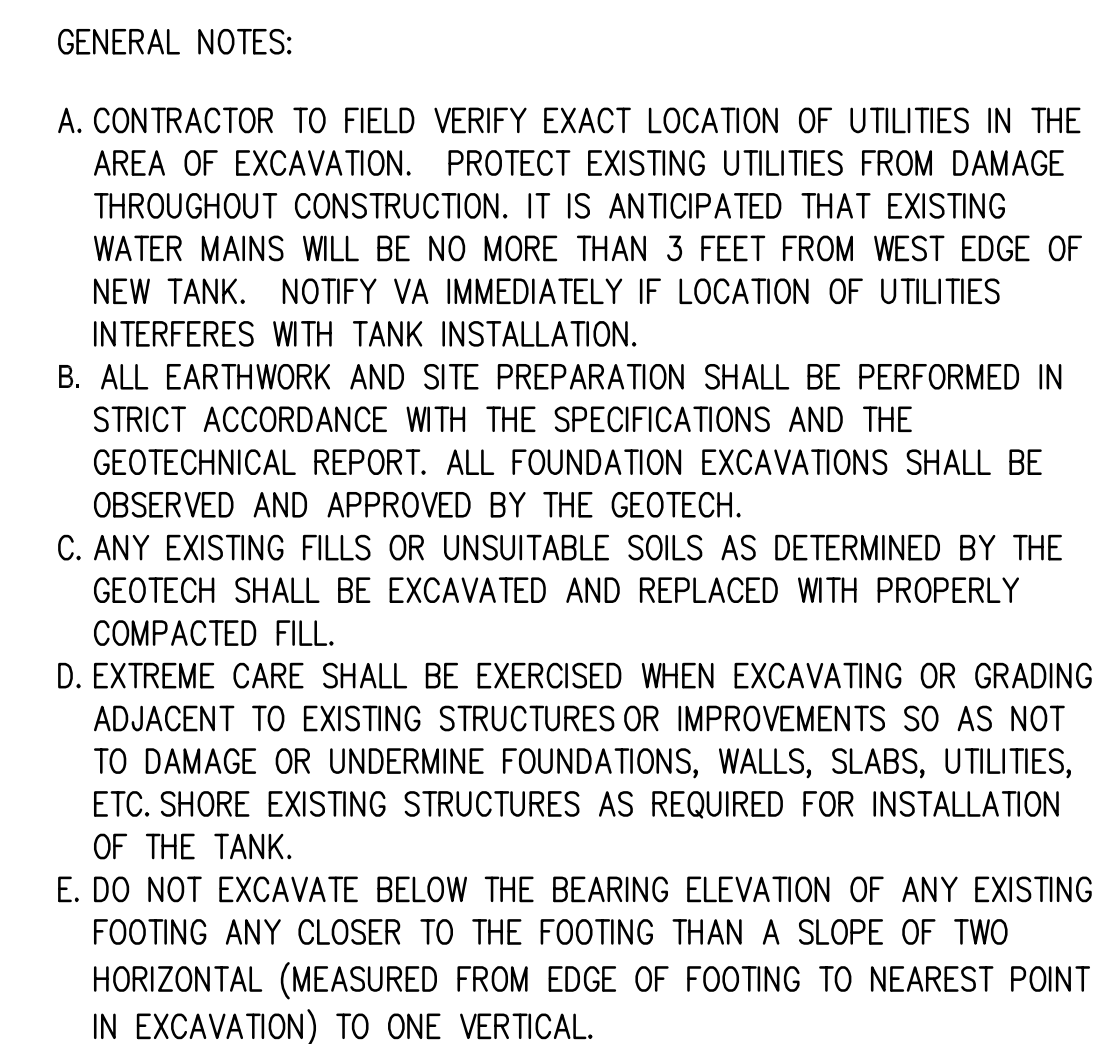

PUMP EMERGENCY SIGNAGE AND EQUIPMENT:

PROVIDE THE FOLLOWING SIGNAGE AT THE DISPENSING PUMP:  
IN CASE OF FIRE OR SPILL:

- (1) USE EMERGENCY STOP BUTTON.
- (2) REPORT ACCIDENT BY CALLING (SPECIFY LOCAL FIRE NUMBER AND REPORT LOCATION).


PROVIDE AN EMERGENCY ACCESS PHONE ADJACENT TO THE EMERGENCY STOP BUTTON (EPO). PROVIDE SIGNAGE NEXT TO PHONE INDICATING:  
EMERGENCY PHONE FOR USE IN REPORTING SPILLS AND FIRES.  
NUMBER TO CALL.  
REFER TO ES-101 FOR LOCATION OF EMERGENCY STOP BUTTON (EPO).

UNDERGROUND TANK & BALLAST PAD SCHEDULE														
MARK NUMBER	STORED FLUID	TANK CONST MATERIAL	TANK SIZE		TANK BUOYANT FORCE LBS	WALL THICKNESS		TANK WEIGHT (DRY) LBS	BALLAST PAD WEIGHT LBS	DEPTH OF COVER IN	HOLD DOWN RODS		BASIS OF DESIGN	NOTE
			NOMINAL CAPACITY GAL	DIA.		LENGTH	INNER				OUTER	NUMBER		
				IN	IN		GAUGE	GAUGE						
UT-1	E85	FIBERGLASS	2500	72	13'-6"		--	--	1700		36	4	NOTE 1	XERXES

NOTES:

TYP. TANK SIZE DIMENSIONS VARY SLIGHTLY DEPENDING ON MANUFACTURER.  
TANK BUOYANT FORCE CALCULATED FOR CLEAN WATER (62.4 LBS/CU. FT).  
HOLD DOWN ROD NUMBER AND SIZE BASED ON A 5:1 SAFETY FACTOR FOR TURNBUCKLES.  
PROVIDE UNDERWRITERS APPROVED TANKS FOR USE WITH E85 FUEL.

1. PROVIDE HOLD DOWN RODS AND STRAPS PER MANUFACTURER RECOMMENDED STANDARDS.  
2. CONTRACTOR TO PROVIDE TANK FULL OF E85 FUEL AT END OF PROJECT.

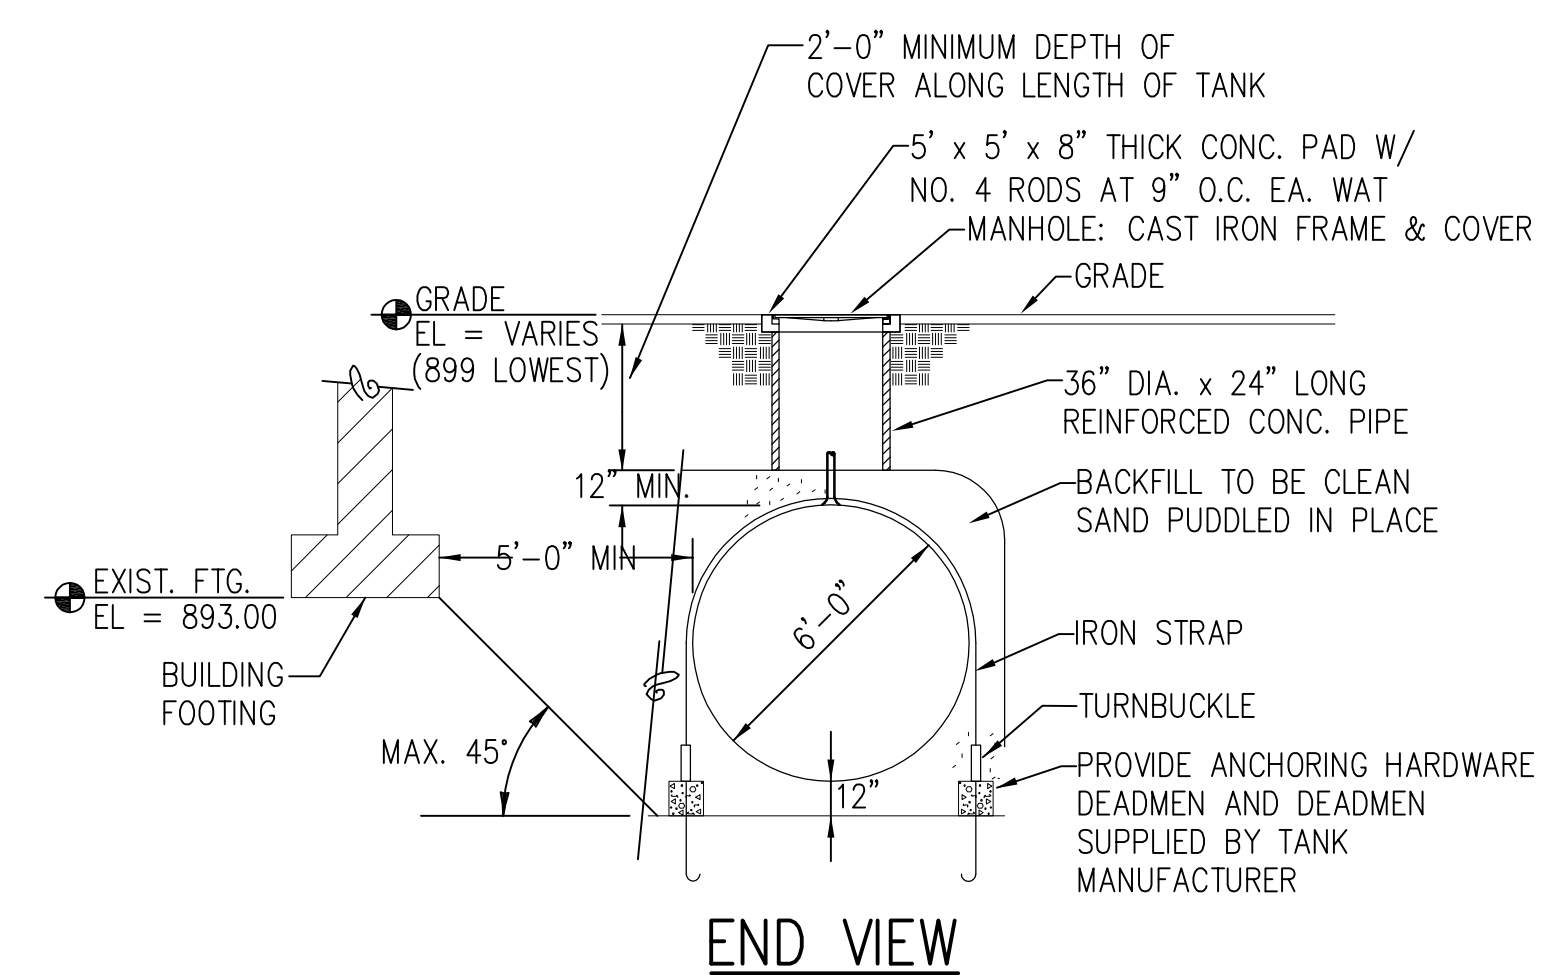


**A4** GASOLINE STORAGE TANK DETAIL  
SCALE: NTS

[illegible]

## PROJECT TEAM

ARCHITECTURAL:	MECHANICAL/ELECTRICAL/ PLUMBING:	STRUCTURAL:	CIVIL / SURVEYOR:	FIRE PROTECTION:	COMMISSIONING AGENCY:	ENVIRONMENTAL SERVICES:
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Drawing Title

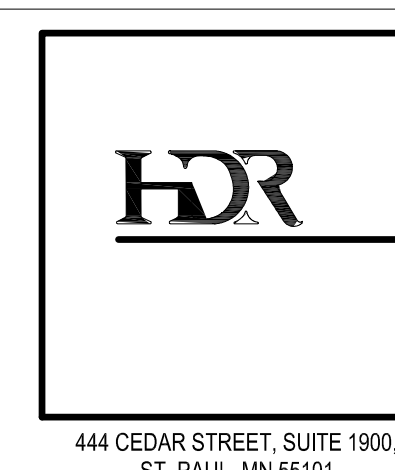MECHANICAL PLAN,  
DETAILS AND SCHEDULE

Approved : Project Director

Project Title	<b>E85 FUEL STATION</b>
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Project Number  
**222514**

[illegible]

Location	3600 30TH STREET DES MOINES, IA 50310
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Date  
08/1/2014

Checked by	
Check	

Drawn  
**H. Phillips**


MS-101

Office of  
Construction  
and Facilities  
Management



# CONSTRUCTION BID DOCUMENTS



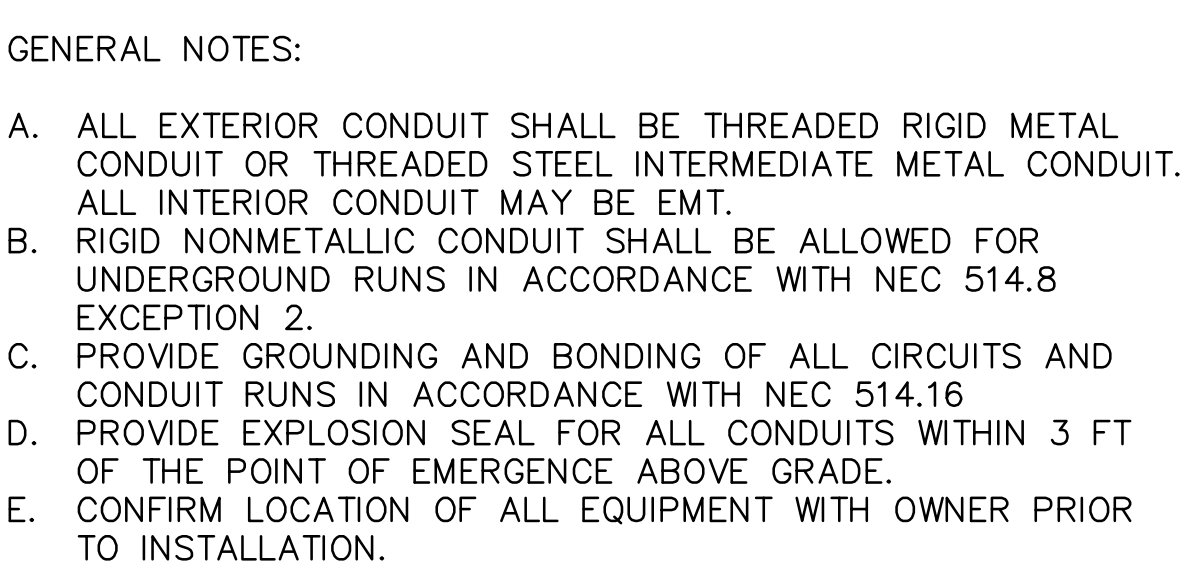

KEYED NOTES:

1. PROVIDE CONNECTION TO FUEL DISPENSER. ROUTE (2)#12, (1)#12 GRD CIRCUIT TO NEW 20/1 CIRCUIT BREAKER IN EXISTING PANEL B-9-B. BREAKER TO MATCH EXISTING. CONDUIT SHALL ENTER BUILDING ABOVE GRADE. CIRCUIT SHALL BE ROUTED THROUGH CONTACTOR.
2. PROVIDE POWER CONNECTION FOR TANK MONITORING AND DISPENSER MONITORING. ROUTE (2)#12, (1)#12 GRD CIRCUIT TO NEW 20/1 CIRCUIT BREAKER IN EXISTING PANEL SERVING AREA. BREAKER TO MATCH EXISTING. CIRCUIT SHALL BE ROUTED THROUGH CONTACTOR.
3. PROVIDE EXTERIOR RATED EPO. EPO TO OPEN CONTACTORS FOR POWER AND COMMUNICATION SIMULTANEOUSLY. PROVIDE SIGN NOTING "GASOLINE PUMP EMERGENCY SHUT OFF SWITCH". SIGNAGE SHALL CONSIST OF WHITE TEXT ENGRAVED ON RED BACKGROUND. TEXT SHALL BE ARIAL FONT 1-1/2" IN HEIGHT. CONTRACTOR SHALL SUBMIT SIGNAGE TEMPLATE FOR APPROVAL PRIOR TO FABRICATION.
4. PROVIDE TWO 200/1, 3-POLE CONTACTORS IN AN ENCLOSURE. ENCLOSURE SHALL BE SIZED TO ALLOW FOR A SECOND SET OF CONTACTORS TO BE ADDED IN THE FUTURE. POWER WIRING SHALL BE ROUTED THROUGH CONTACTORS OPENING HOT, NEUTRAL, AND GROUND.
5. ROUTE 1" CONDUIT FROM FUEL OIL CONTROL PANEL THROUGH COMMUNICATION-RATED CONTACTOR TO FUEL DISPENSER FOR COMMUNICATION WIRING.
6. PROVIDE TWO LOW VOLTAGE, COMMUNICATION RATED, 4-POLE, CONTACTORS IN AN ENCLOSURE. ENCLOSURE SHALL BE SIZED TO ALLOW FOR A SECOND SET OF CONTACTORS TO BE ADDED IN THE FUTURE.
7. ROUTE 1" CONDUIT FROM FUEL OIL CONTROL PANEL THROUGH COMMUNICATION-RATED CONTACTOR TO UNDERGROUND STORAGE TANK FOR COMMUNICATION WIRING.
8. FUEL OIL CONTROL PANEL PROVIDED BY MECHANICAL.
9. PROVIDE CONNECTION FOR EMERGENCY PHONE. PHONE SHALL BE USED FOR COMMUNICATION IN EVENT OF EMERGENCY FUEL SYSTEM SHUTDOWN. ROUTE CONDUIT BACK TO NEAREST TELECOMMUNICATIONS CLOSET FOR CONNECTION TO EXISTING TELECOMMUNICATION SYSTEM.

(B1) ELECTRICAL SITE PLAN  
SCALE: 1:5

[illegible]

## PROJECT TEAM

ARCHITECTURAL: MECHANICAL/ELECTRICAL/ PLUMBING: STRUCTURAL: CIVIL / SURVEYOR: FIRE PROTECTION: COMMISSIONING AGENCY: ENVIRONMENTAL SERVICES:

**ARCHITECTS/ENGINEERS**
**ANDERSON**  
ENGINEERING

ENGINEERING • ARCHITECTURE • LAND SURVEYING  
ENVIRONMENTAL SERVICES • LANDSCAPE ARCHITECTURE



INCORPORATED  
INFRASTRUCTURE AND ENVIRONMENT

# HDR

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44 CEDAR STREET, S  
ST. PAUL, MN 55

Drawing Title

# ELECTRICAL SITE PLAN

Approved : Project Director

Project Title

### E63 FUEL STATION

Source: U.S. Department of Commerce, Bureau of Economic Analysis, *Survey of Current Business*, Table 1.10.

Location	Drawn from
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3600 30TH STREET DES MOINES, IA 50310

Date	Checked by	Drawn
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08/1/2014	Checker	H. Phillips	
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Project Number:

Building Number

Building Name

Drawing numb

0.000000

E3

Office of  
Construction  
and Facilities  
Management



# CONSTRUCTION BID DOCUMENTS